




A EX. GROUND FLOOR-PARTIAL
SCALE = 1/4"=1'-0"

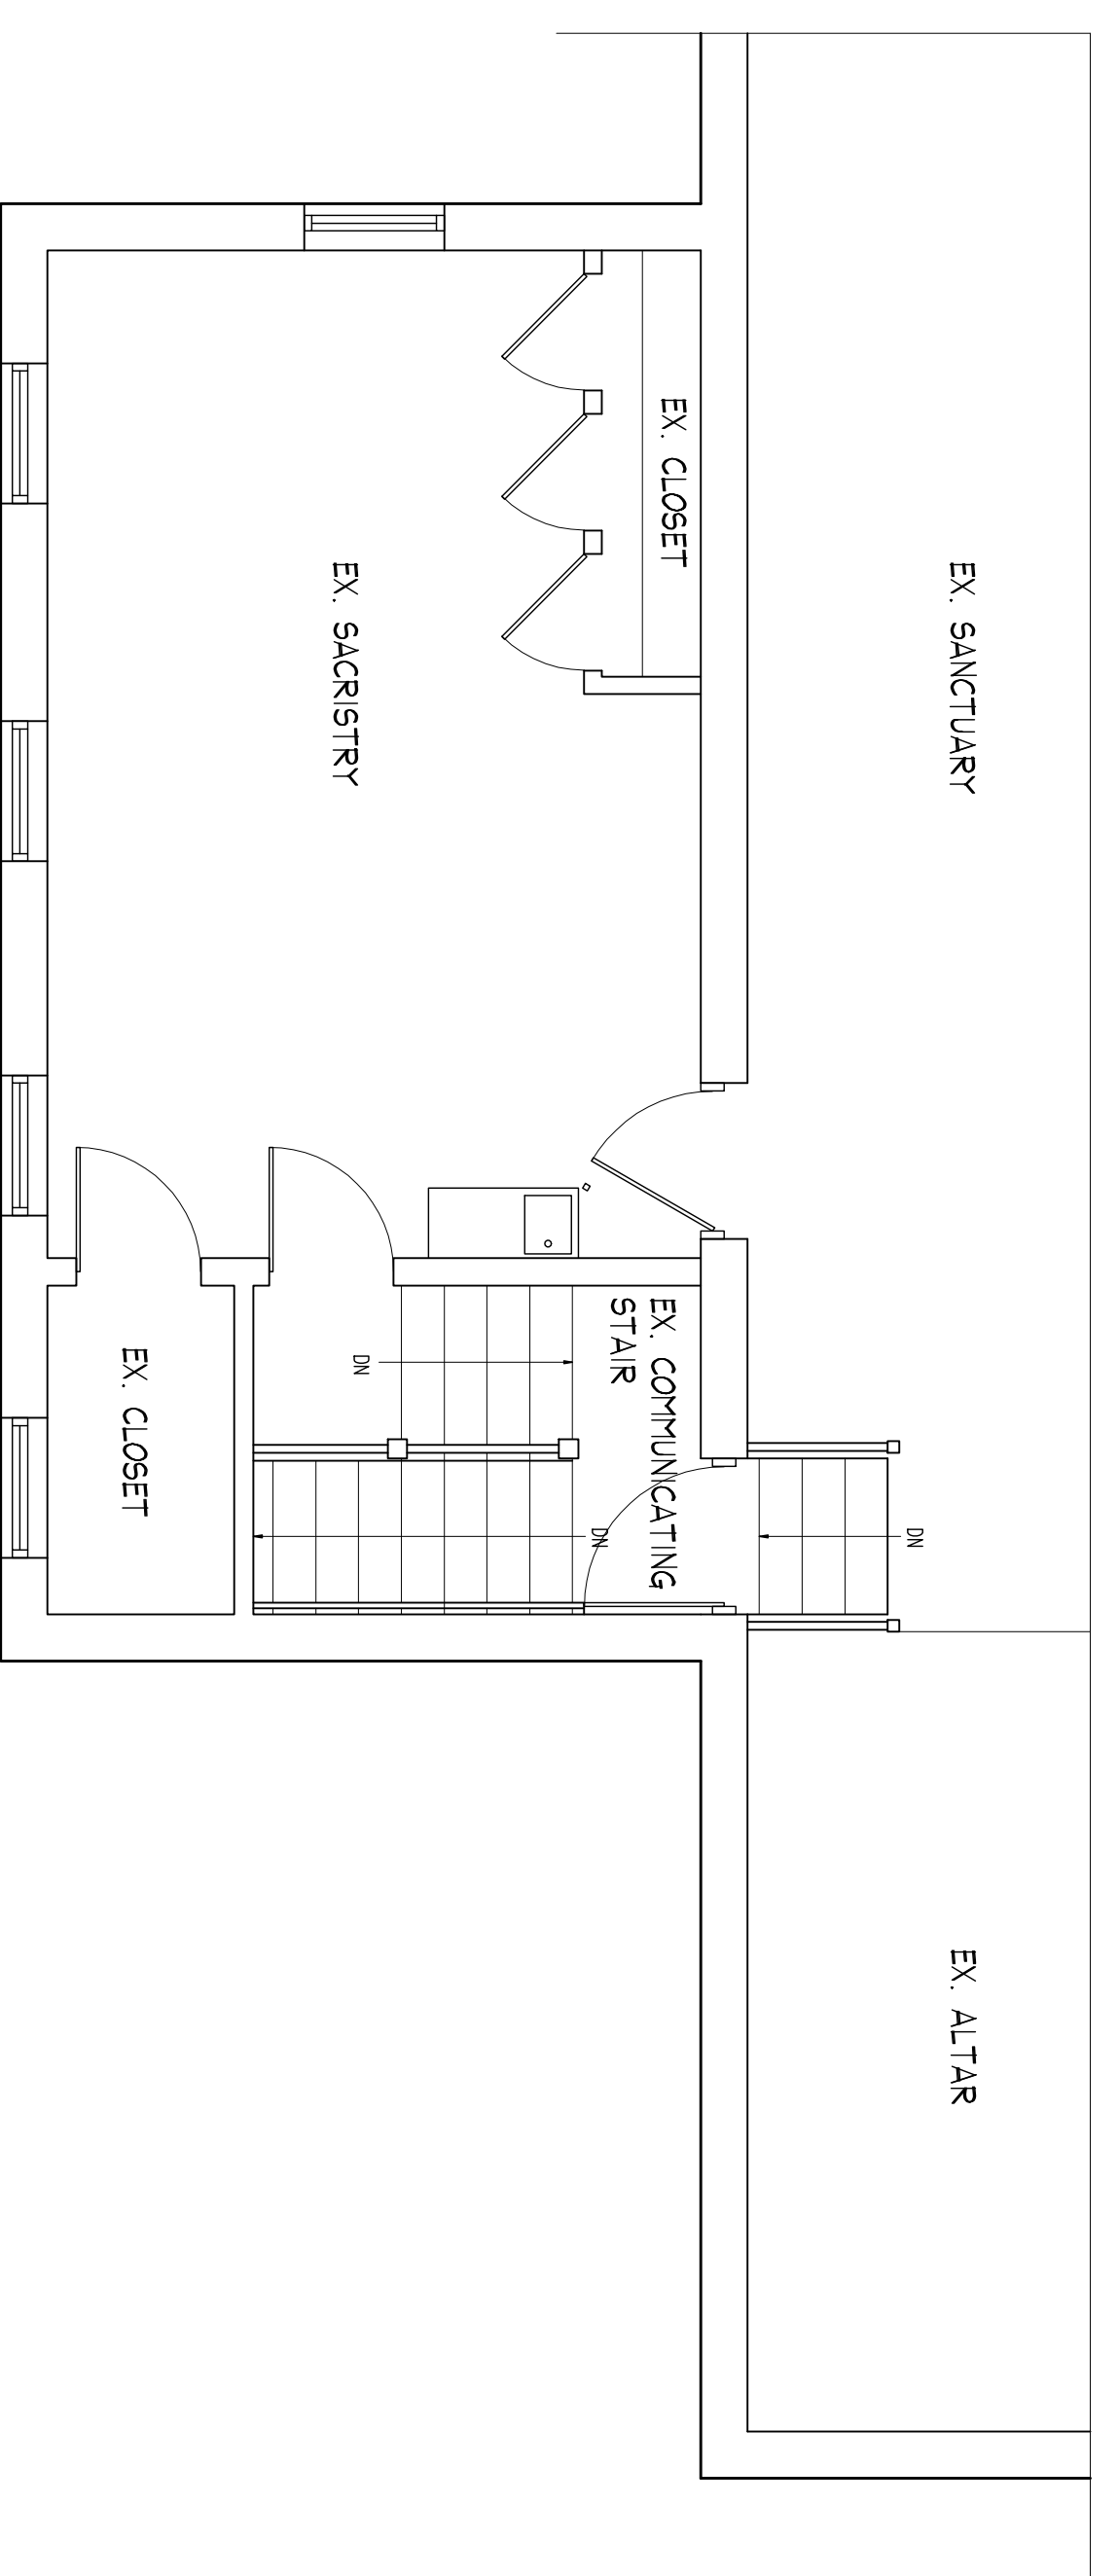


B EX. 2ND FLOOR - PARTIAL
SCALE = 1/4"=1'-0"

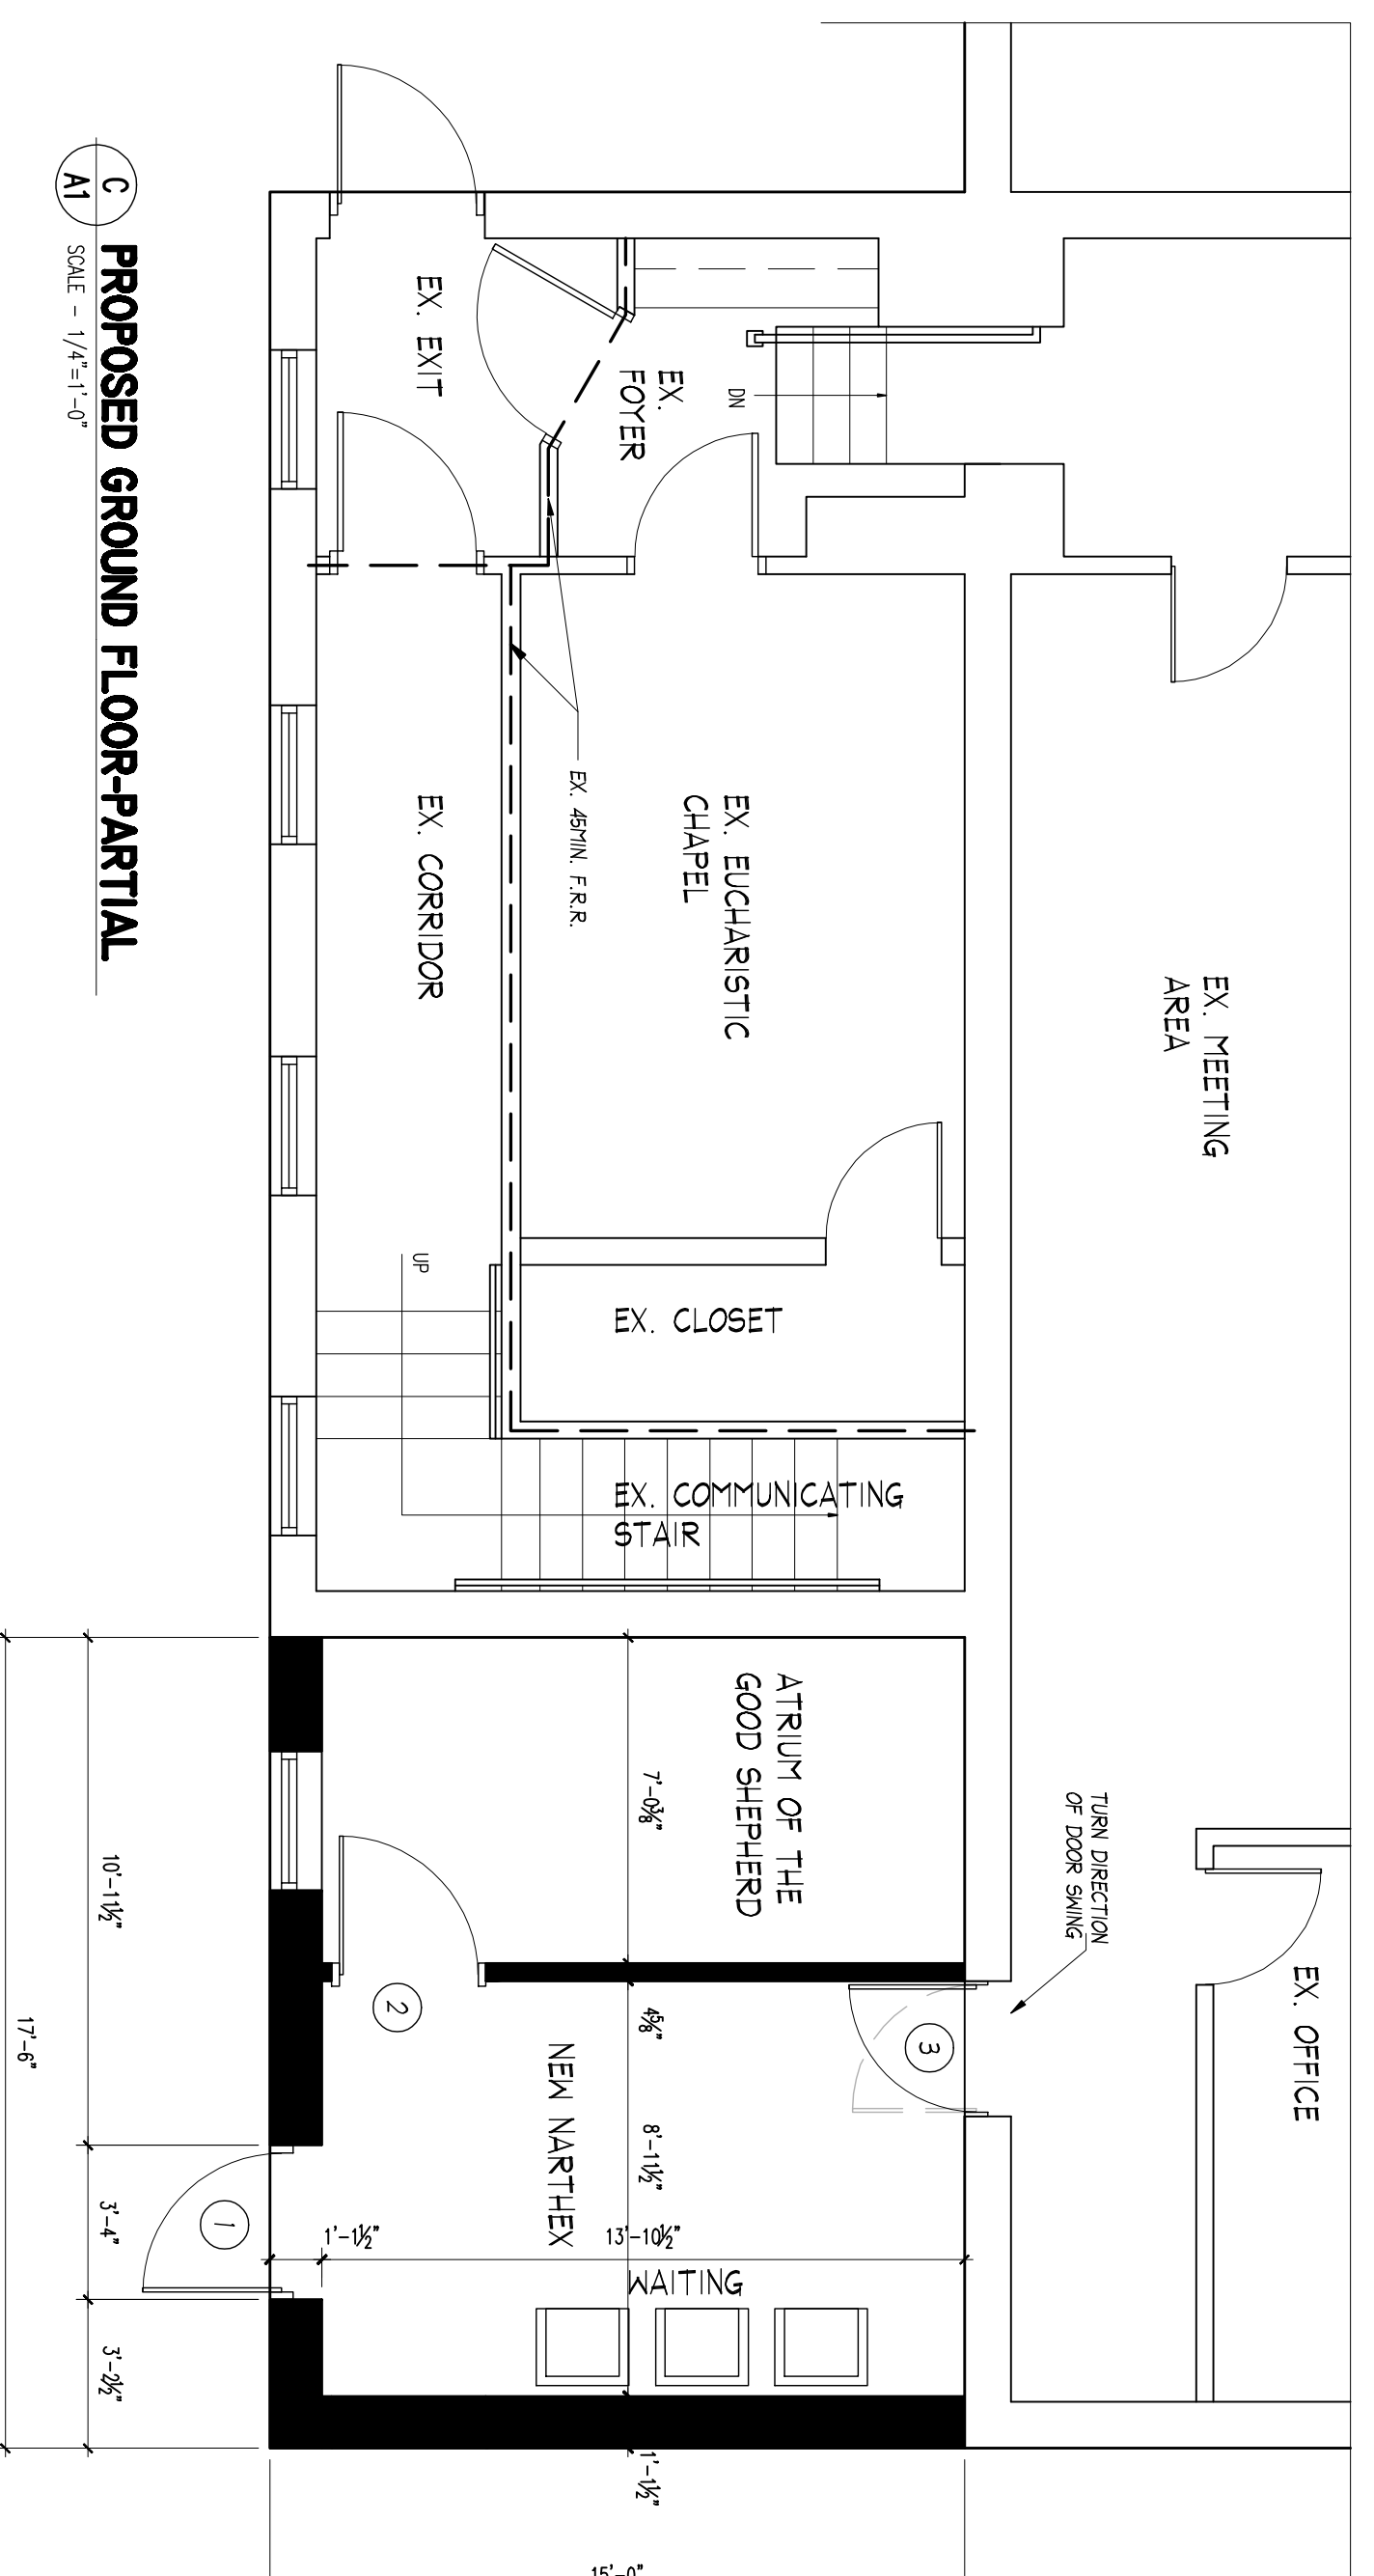


C PROPOSED GROUND FLOOR-PARTIAL
SCALE = 1/4"=1'-0"

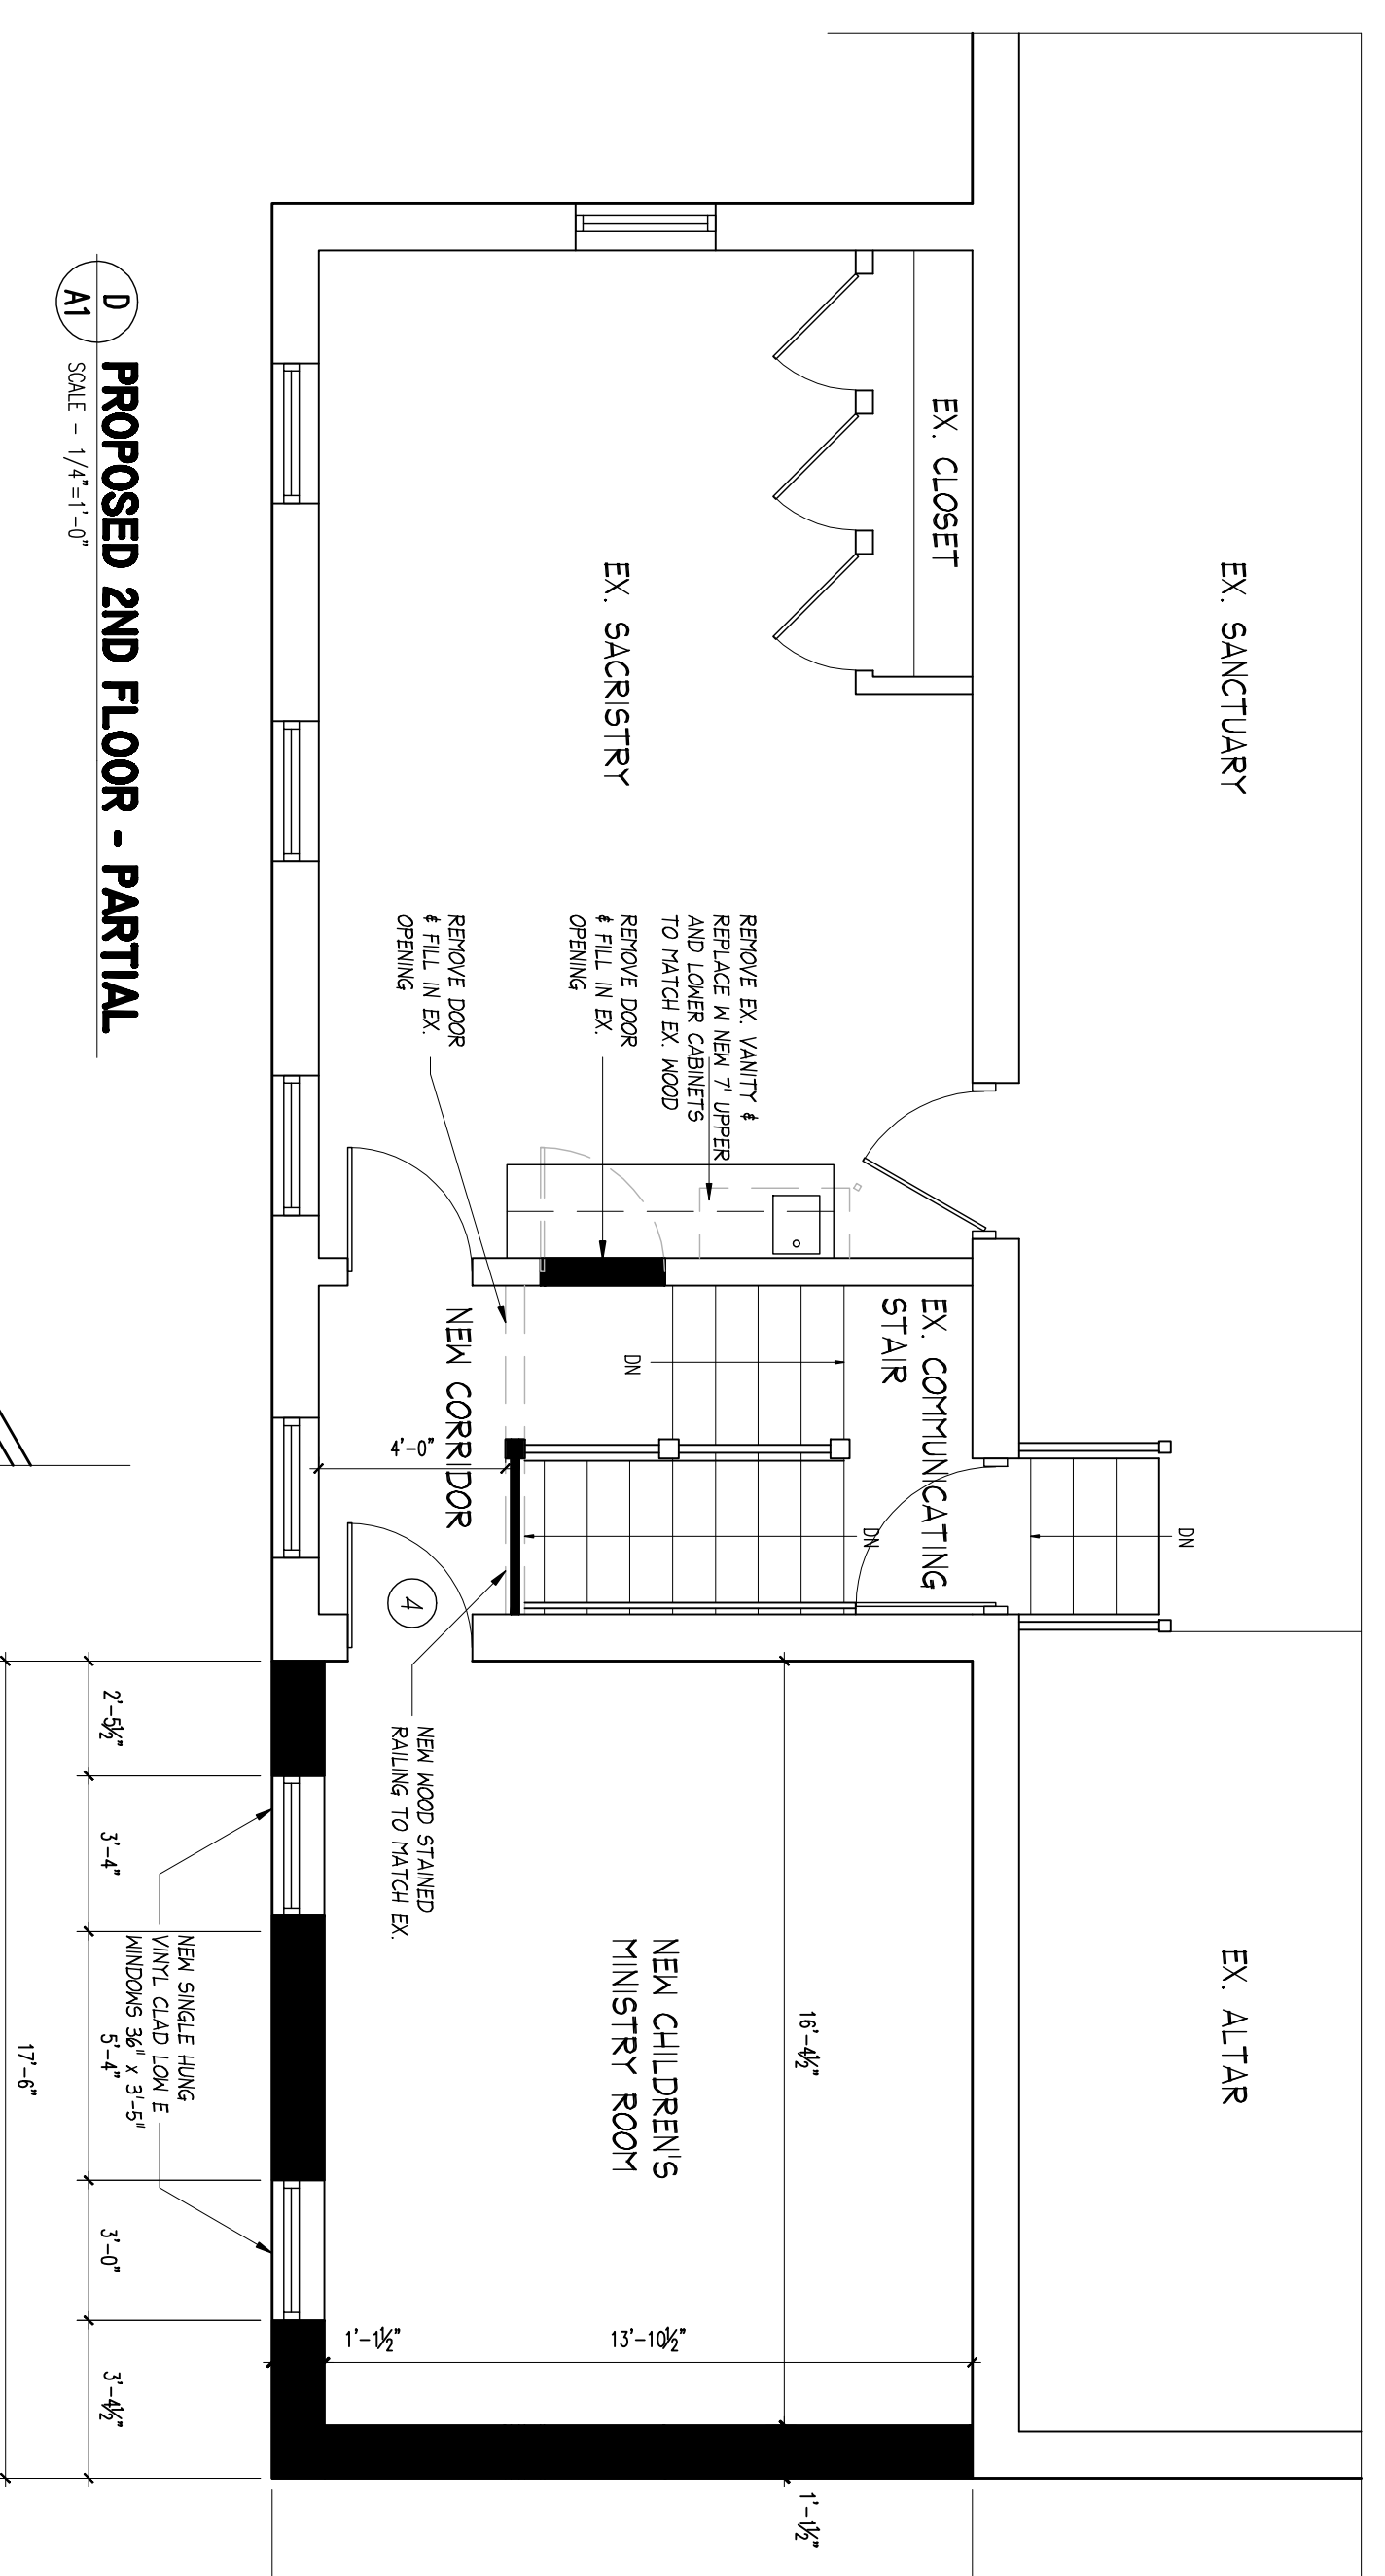

D PROPOSED 2ND FLOOR - PARTIAL
SCALE = 1/4"=1'-0"

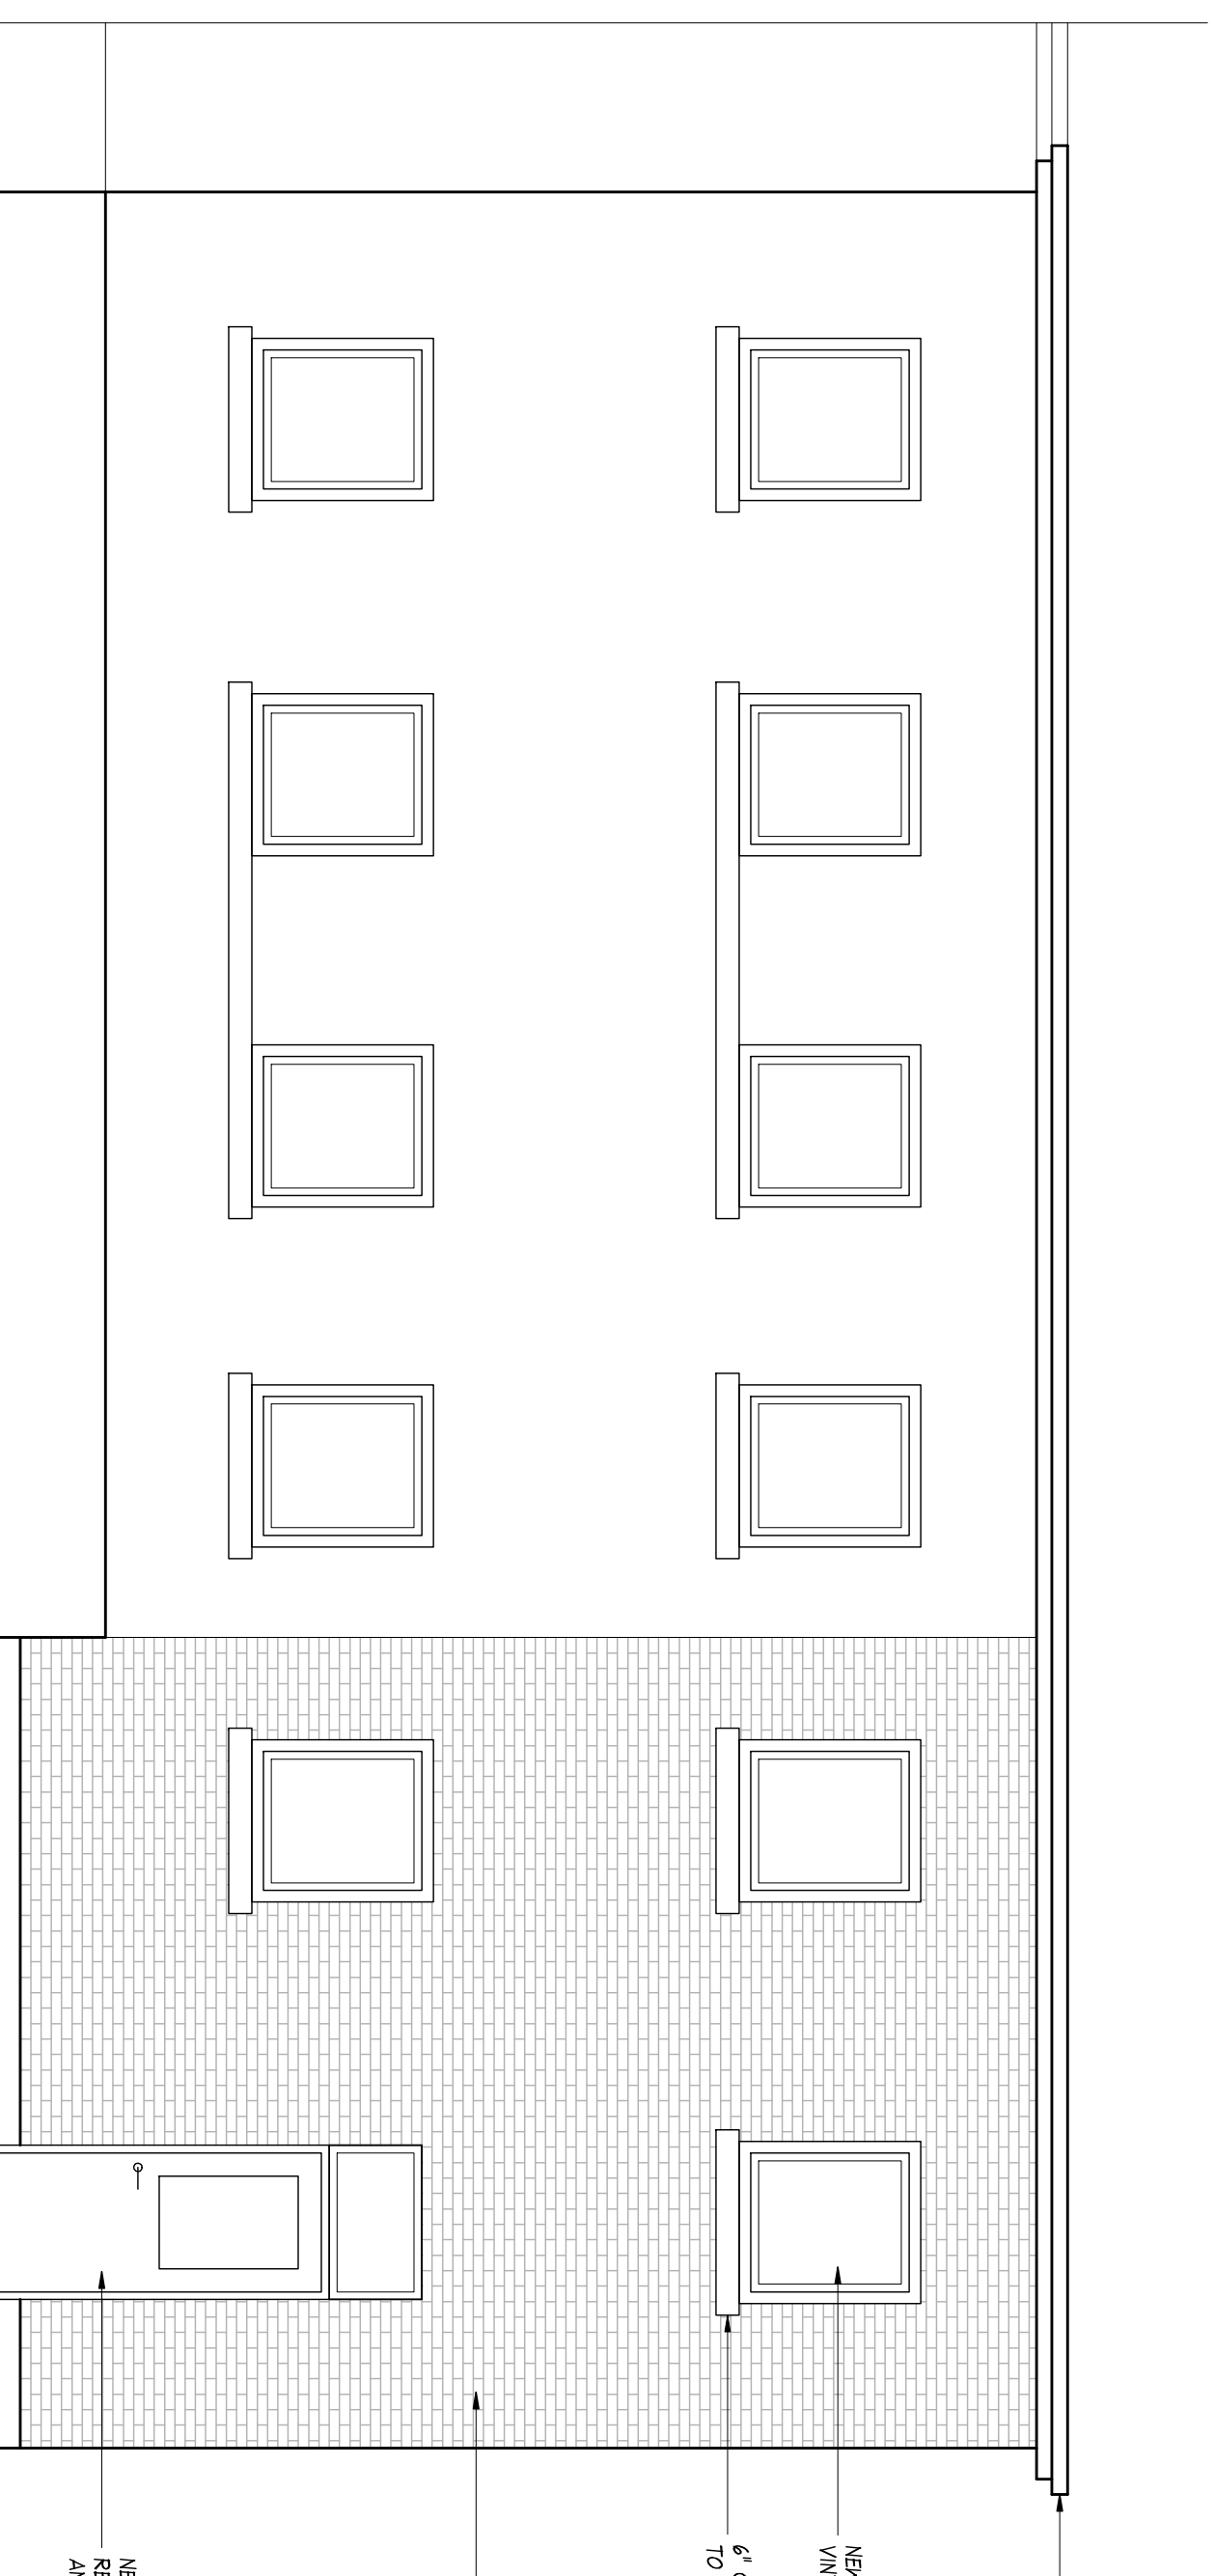



E PROPOSED NORTH ELEVATION
SCALE = 1/4"=1'-0"

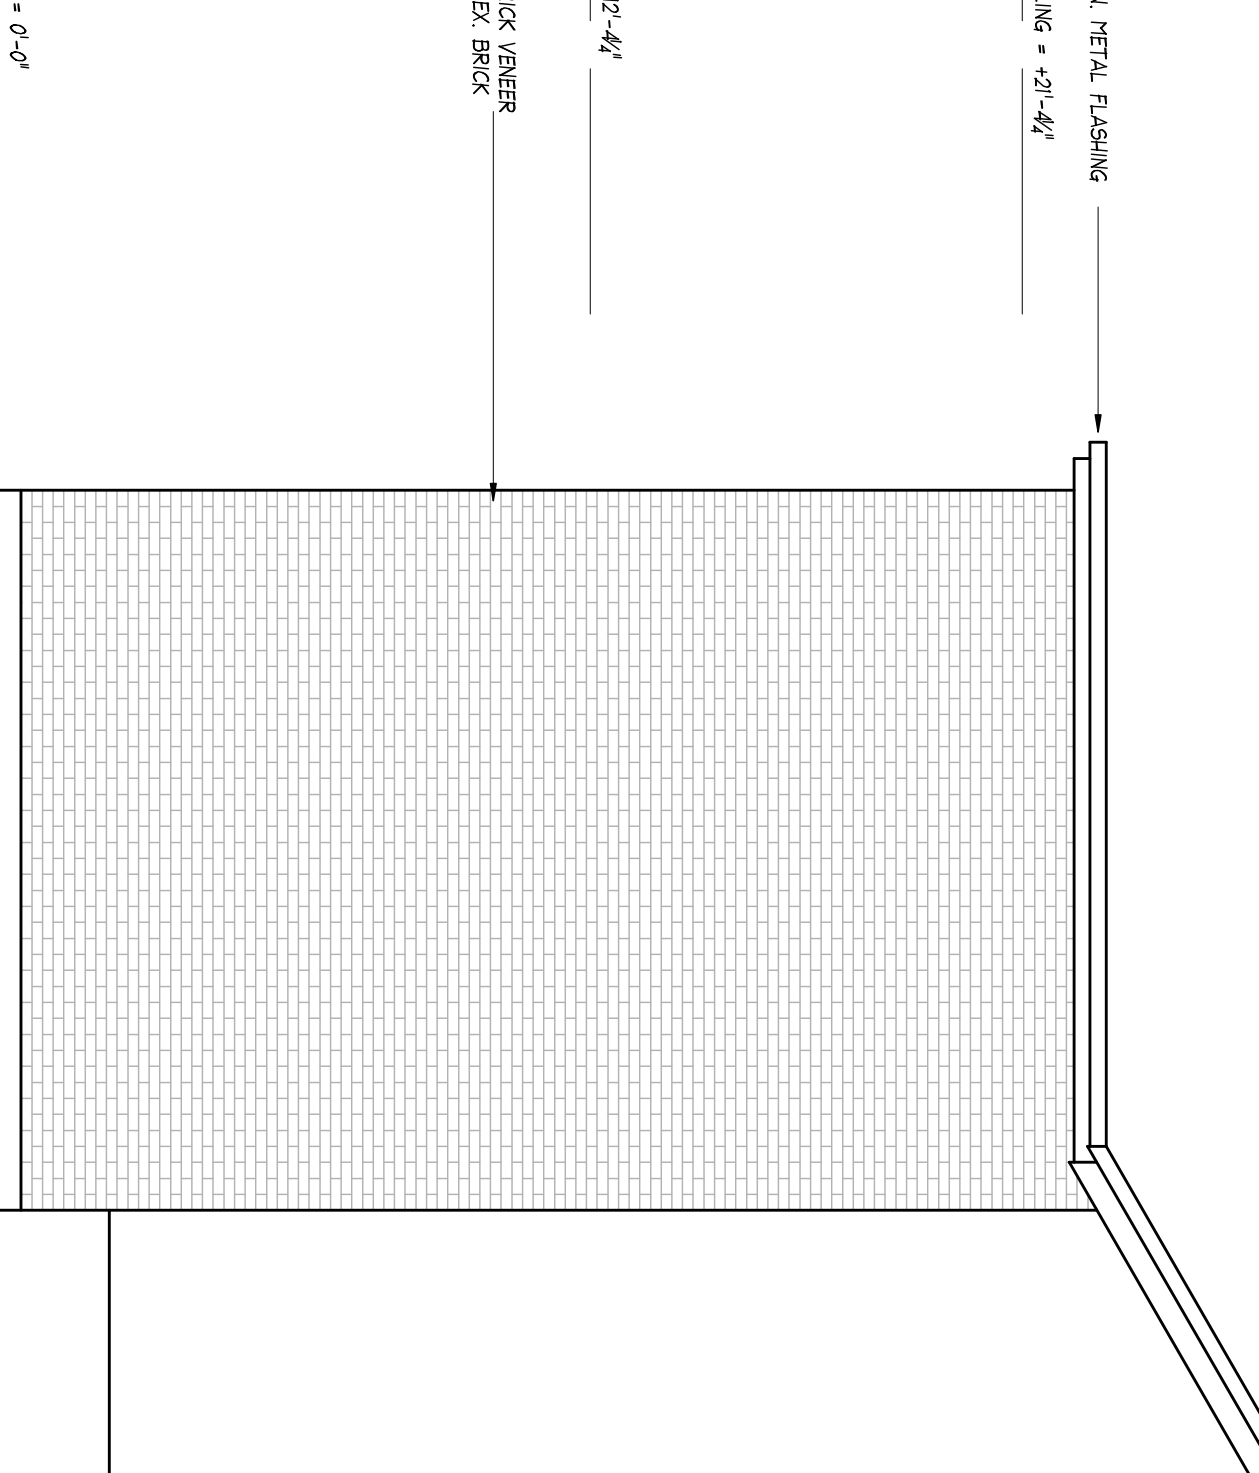

F PROPOSED SOUTH ELEVATION
SCALE = 1/4"=1'-0"

NEW EAVES AND PEREN. VERTICAL FLASHING
2ND FLOOR CEILING = 2'-11"-4 1/2"
NEW PAVED GLASS UNIT
VINYL CLAD LOW E
8" CONCRETE SILL
TO MATCH EXISTING
2ND FLOOR = 12'-4 1/2"
NEW WHITE BRICK VENEER
TO MATCHING EX BRICK
NEW INSULATED STEEL
RES. DOOR CW HALF LIFE
AND TRANSOM WINDOW
GROUND FLOOR = 0'-0"

- TYPICAL INTERIOR PARTITION WALL CONSTRUCTION**
1/2" GYPSUM BOARD
3 5/8" STEEL STUDS AT 16" O/C
R12 BATT INSULATION
1/2" DRYWALL
- TYPICAL EXTERIOR WALL CONSTRUCTION**
3/4" CONCRETE ON GRADE
3/4" RIGID INSULATION (CONT.)
2" RIGID INSULATION (CONT.)
6" S.S. STUDS AT 16" O/C
R20 BATT INSULATION
6 mm POLY VAPOR BARRIER
1/2" DRYWALL
- TYPICAL ROOF CONSTRUCTION**
FRAM & GABLE FROM MEMBRANE
R12 FIBROGLASS SHEATHING
5.5 JOISTS AT 16" O.C. (OR TOP OF STUDS) IF DRIVETAIL

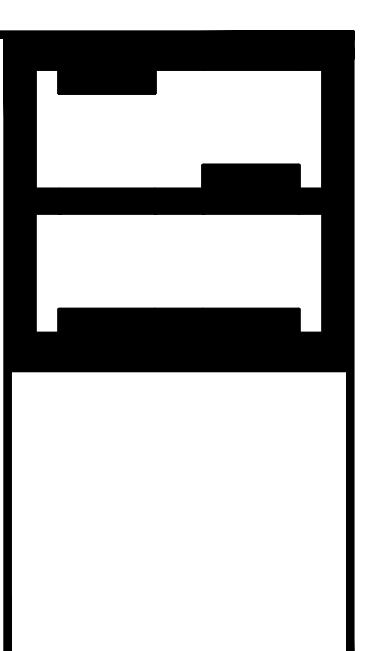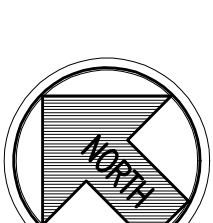

SCHIEDEL
CONSTRUCTION INCORPORATED
GENERAL CONTRACTORS-PROJECT MANAGERS
400 QUEEN ST W CAMBRIDGE ONT. N6C 1G6 664-9317
email address: reception@schiedelconstruction.com
PROJECT

2013 OFFICE ADDITION
ST. MARY'S CHURCH

COOPER RD.
CAMBRIDGE, ONTARIO

SCALE	DATE	DRAWN BY	PROJECT NO.
1/4"=1'-0"	Apr/2013	AS	2013-13

DRAWING NO. **A1**